# PORT OF TAGOMA

## FABULICH CENTER BUILDING ENVELOPE RESTORATION 101529.02 **CONTRACT #071645**

## PORT COMMISSIONERS:


RICHARD P. MARZANO **DON MEYER JOHN MCCARTHY KRISTIN ANG DEANNA KELLER** 

## PORT STAFF:

**ERIC JOHNSON** Port of Tacoma Executive Director

THAIS HOWARD, P.E. **Director of Engineering** 

NORMAN GILBERT, P.E. **Project Manager** 

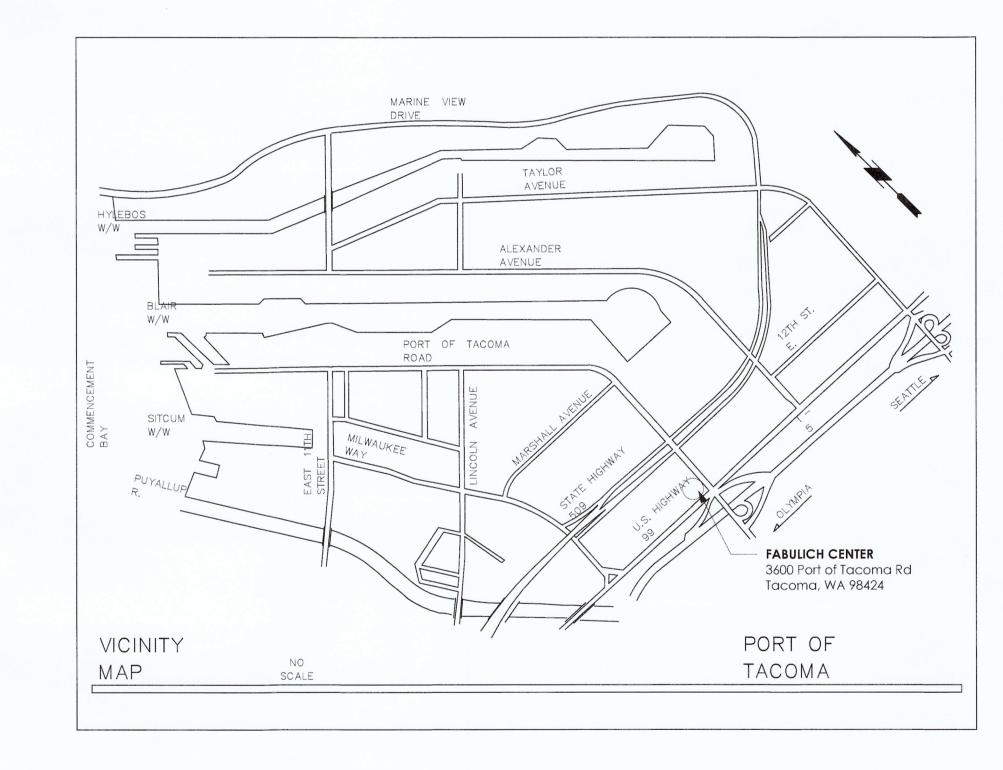



DRAWING LIST			
SHEET DESIGNATION	SHEET #	SHEET TITLE	REVISION
G1.01	1	COVER SHEET	
A5.01	2	EXTERIOR ELEVATIONS	
A5.02	3	EXTERIOR ELEVATIONS	
D1.01	4	EXTERIOR WALL AND WINDOW PHOTOS	
W3.01	5	EXTERIOR WALL AND WINDOW DETAILS	
W3.02	6	WINDOW WET FLASH DETAILS	








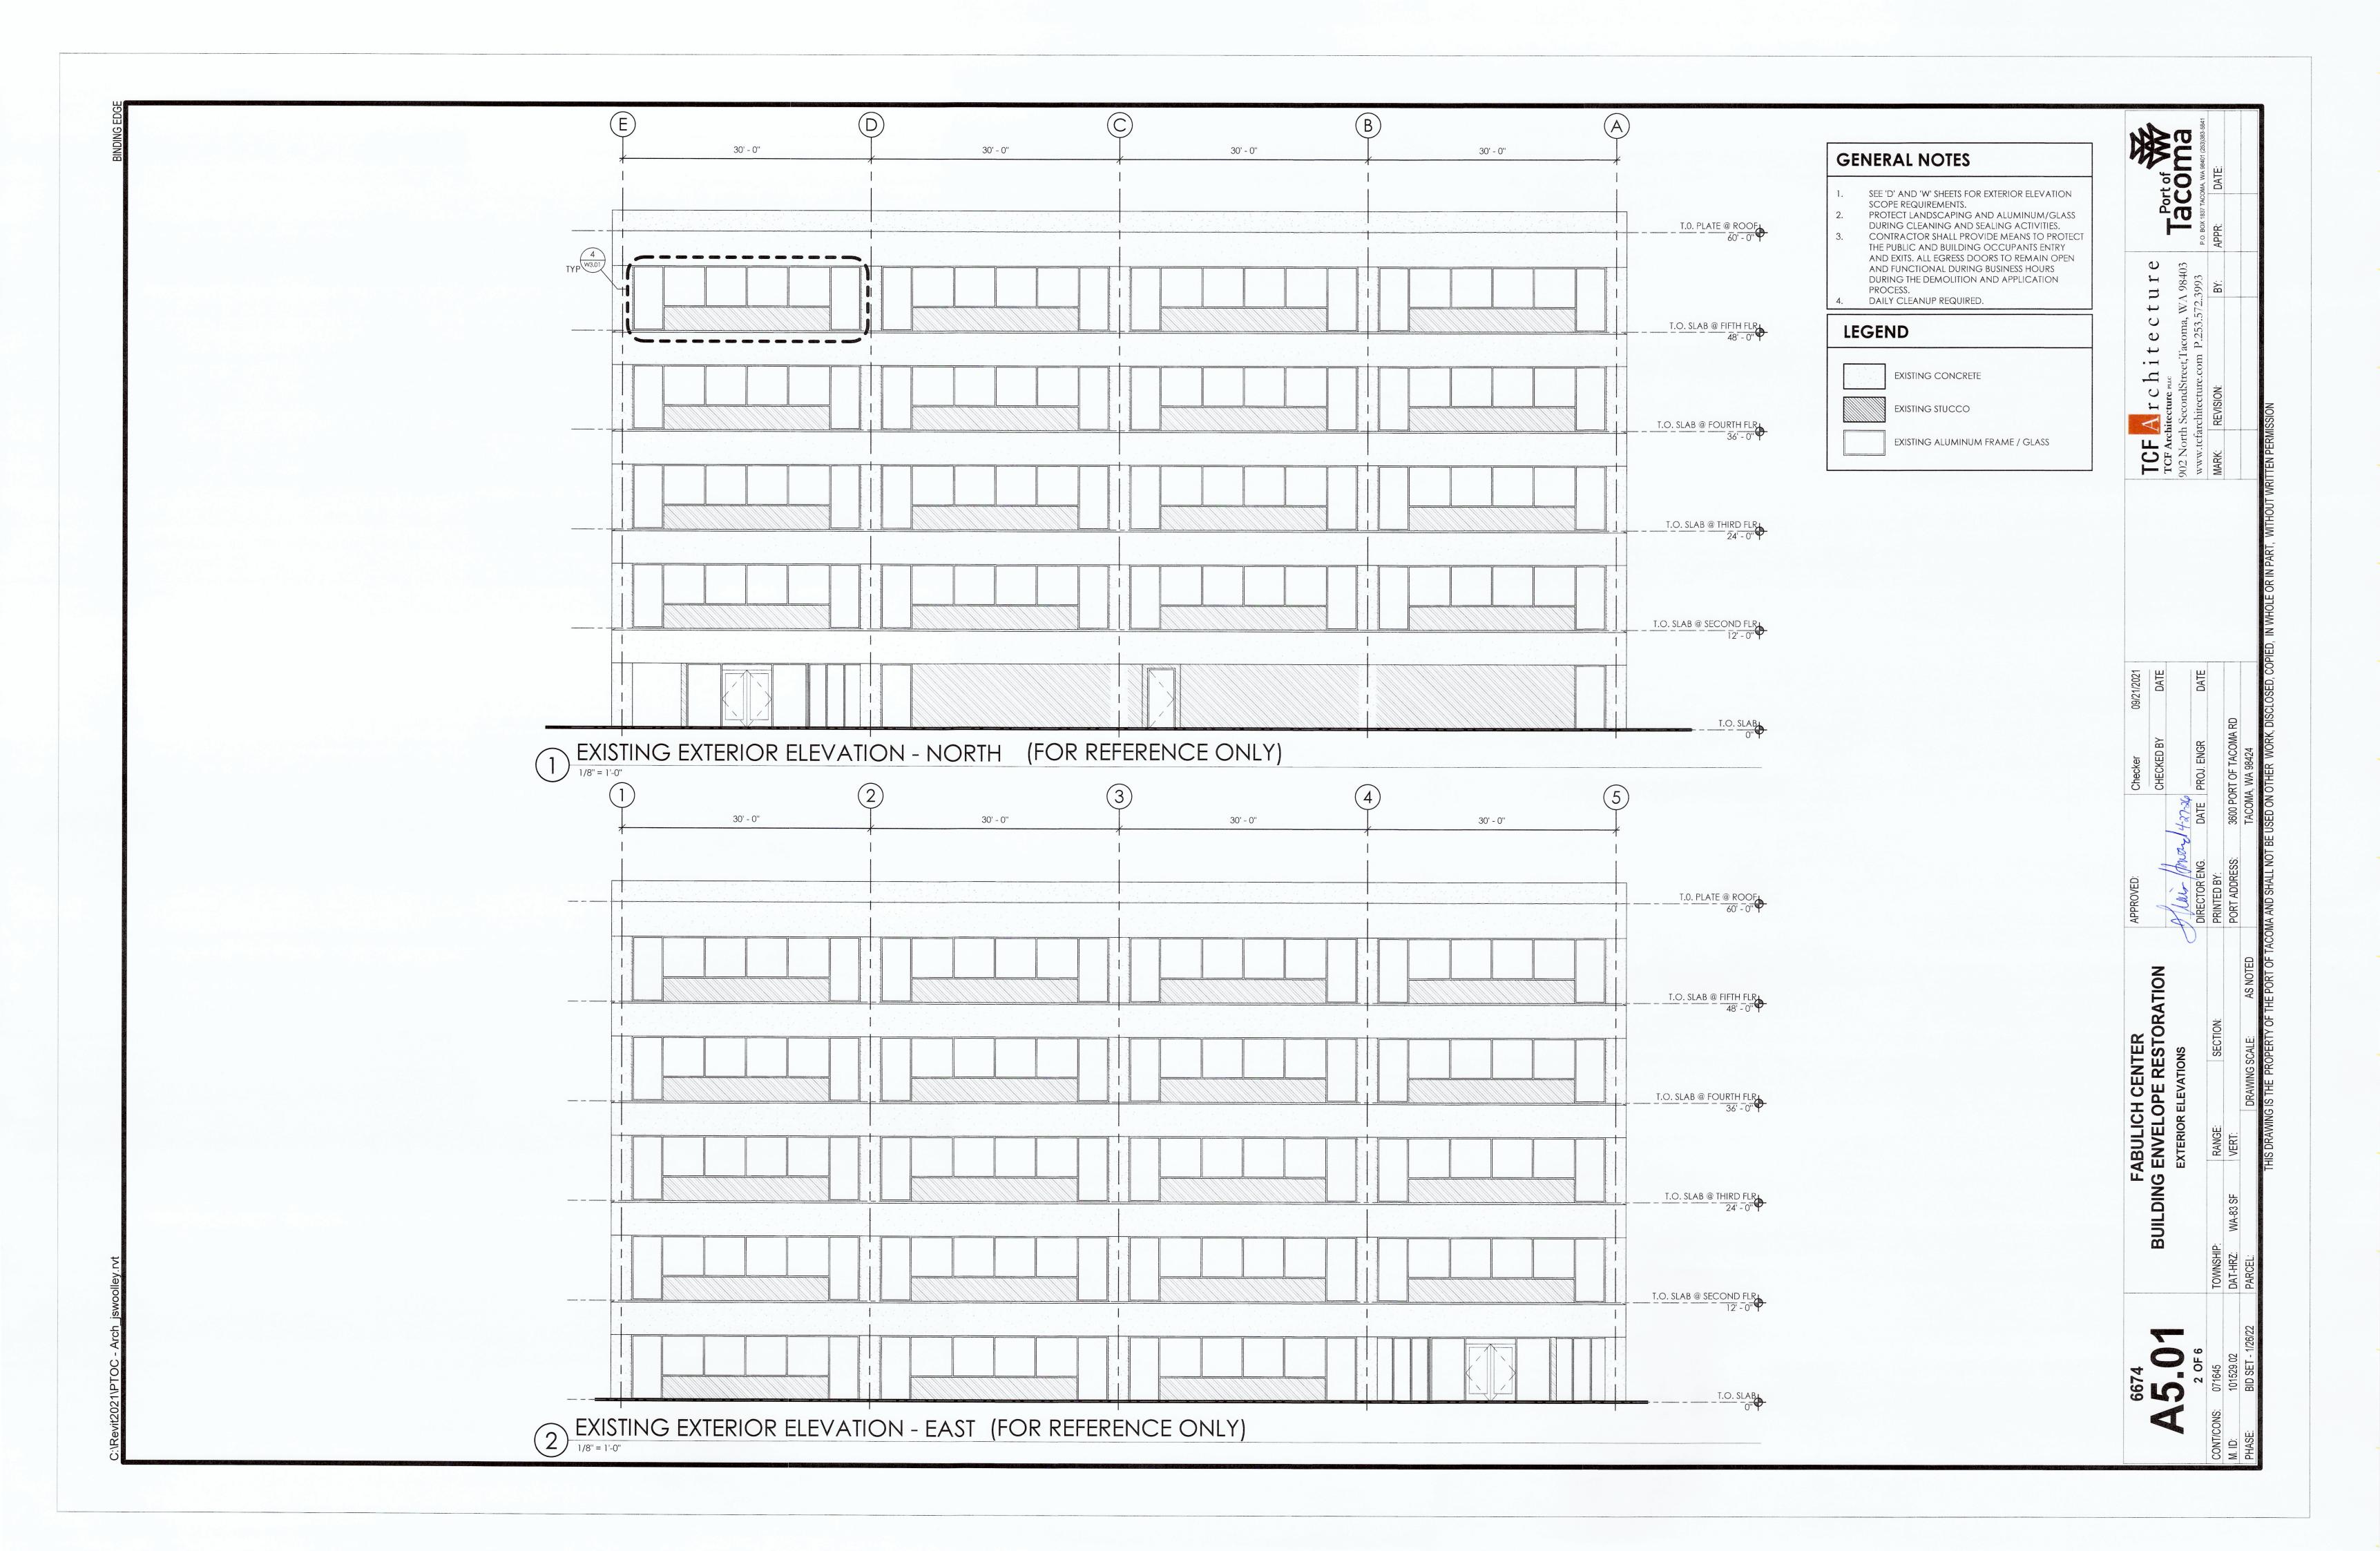


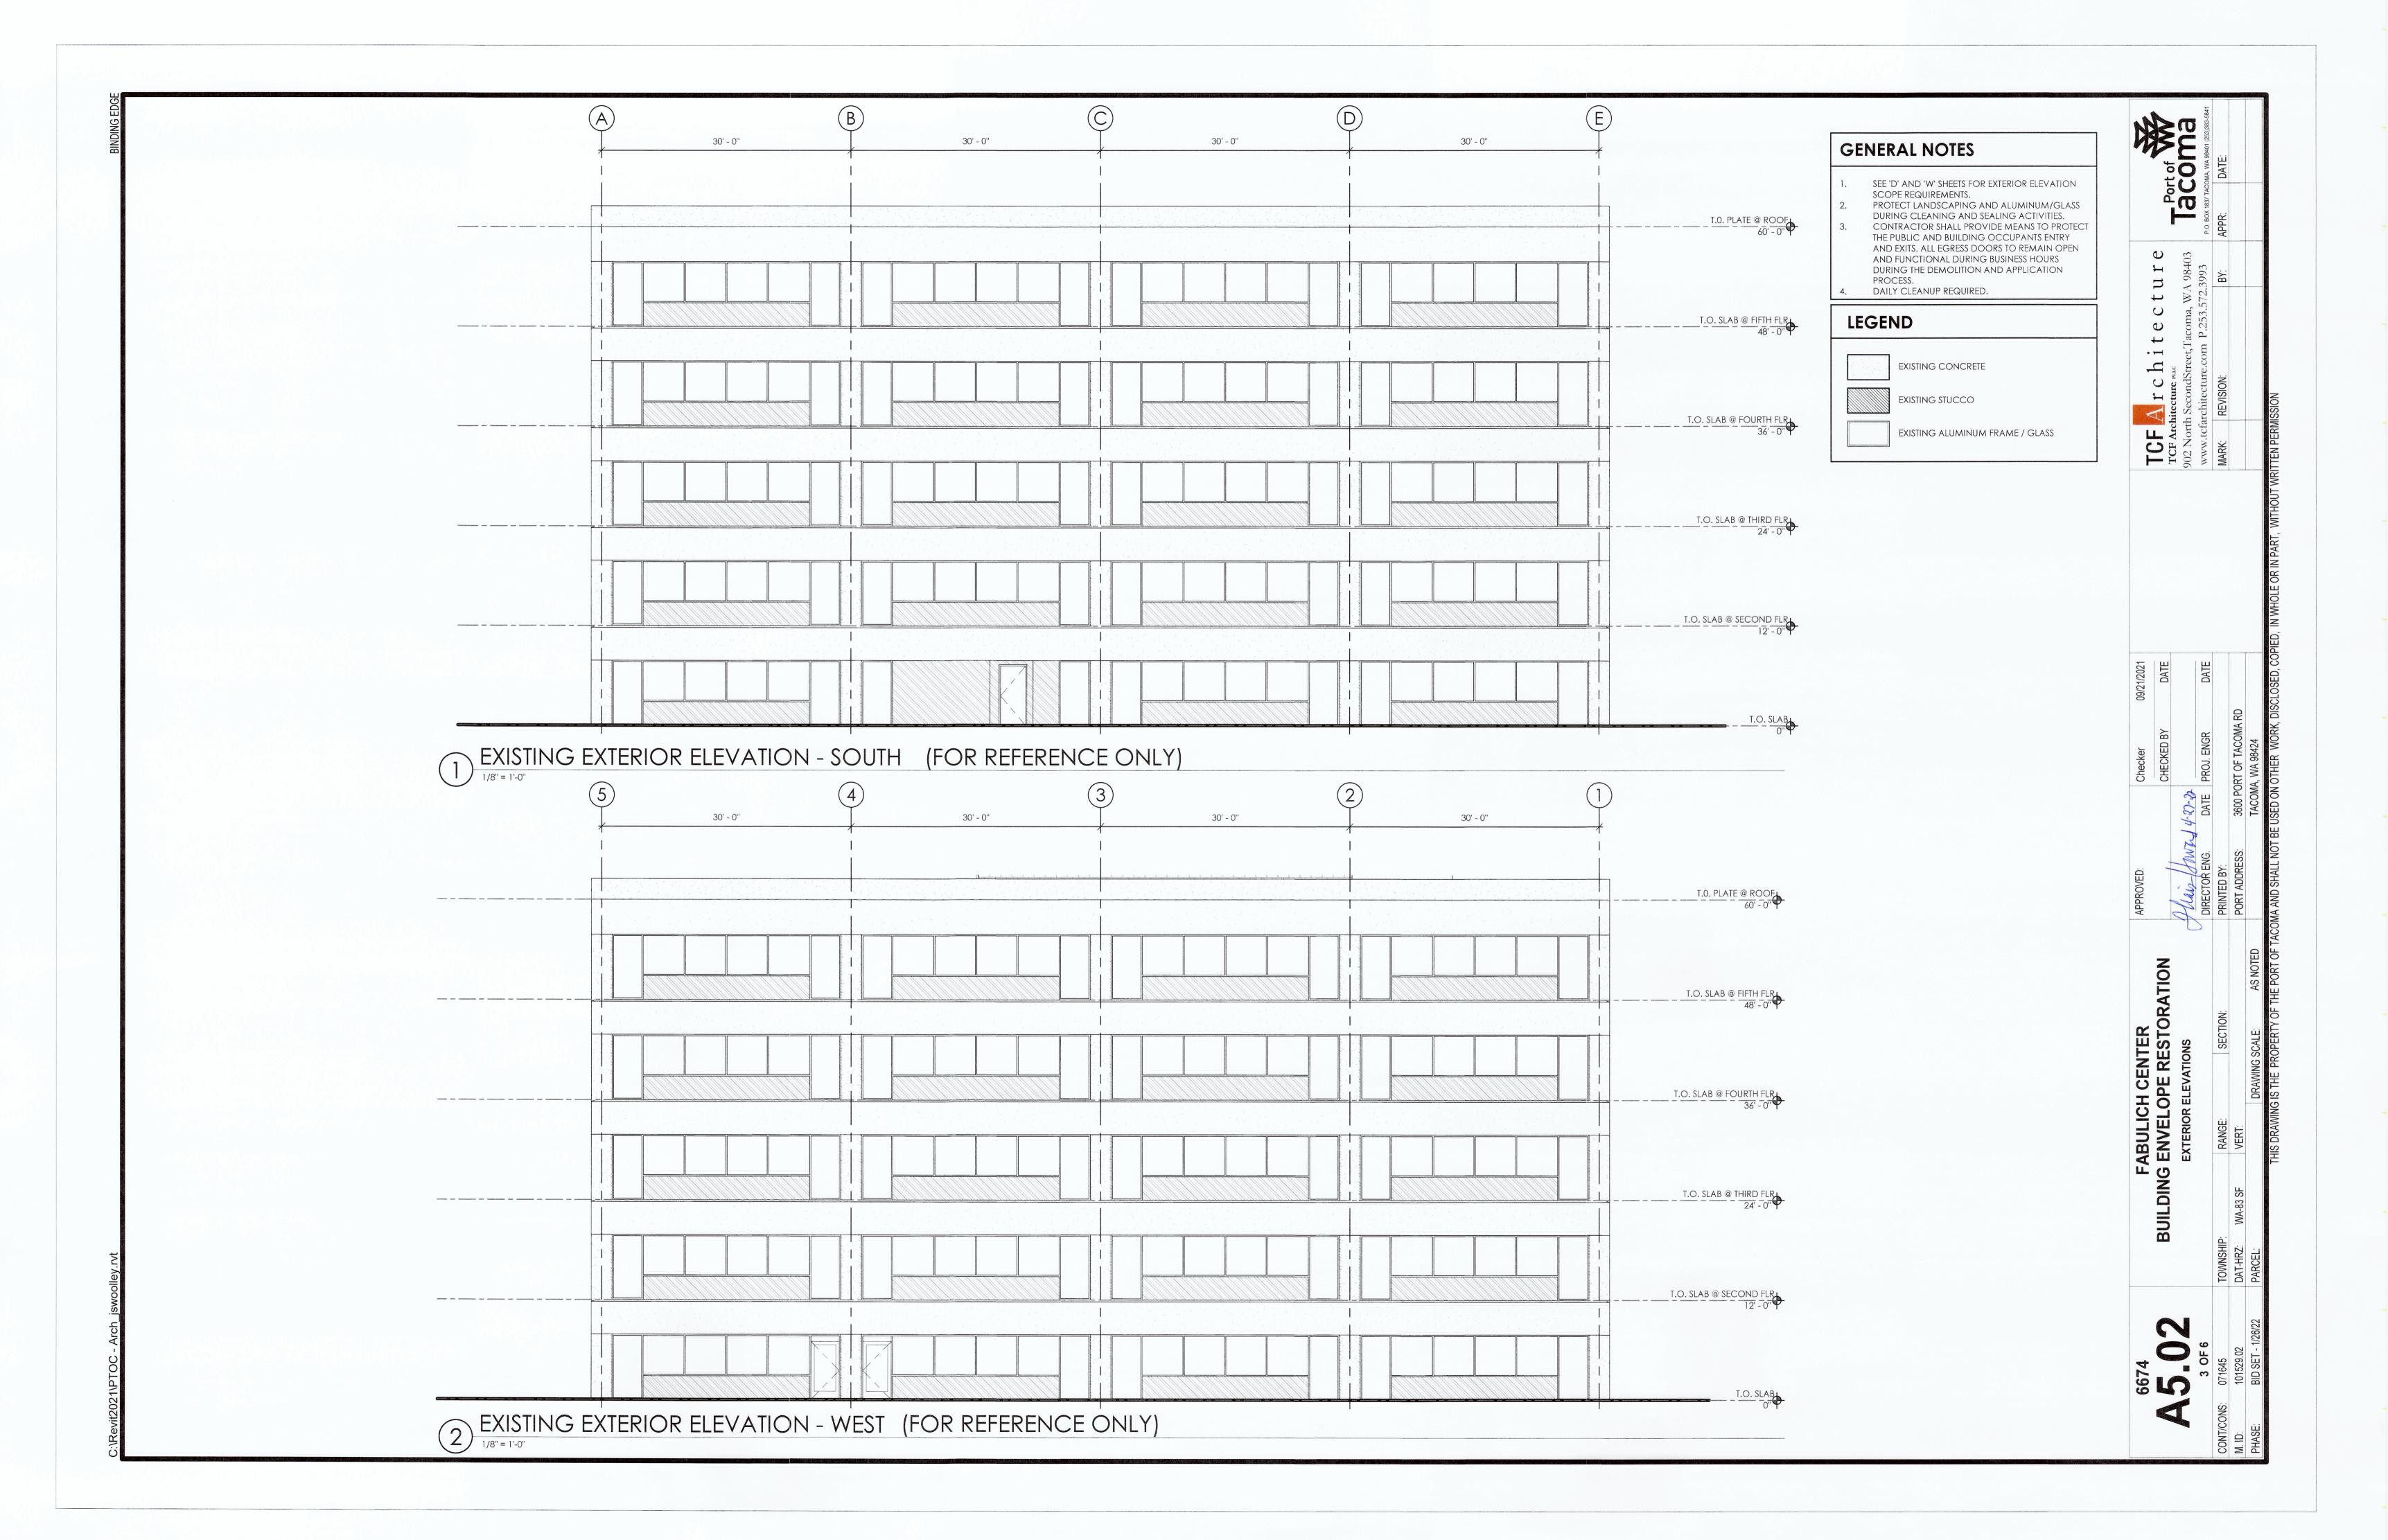




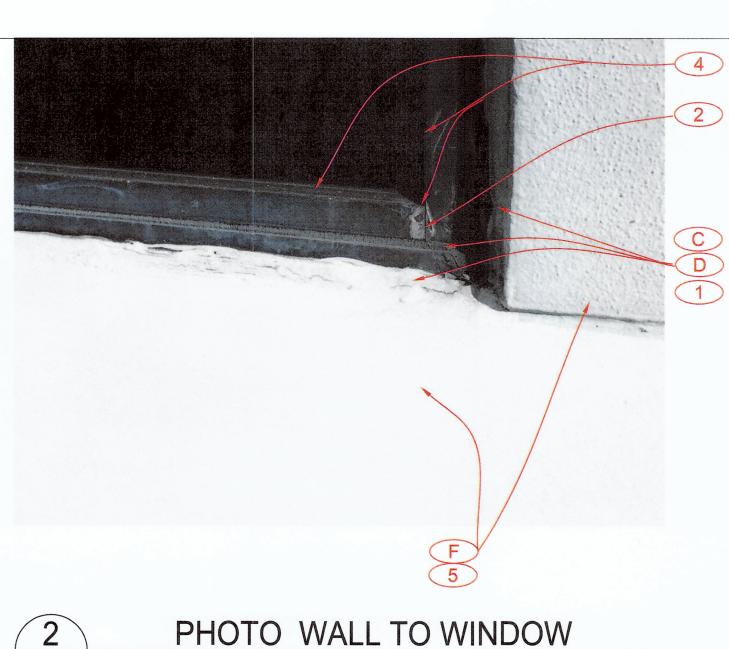

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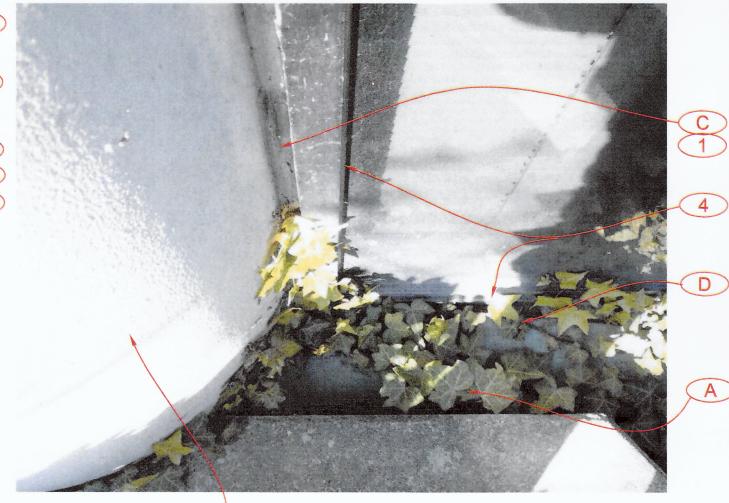


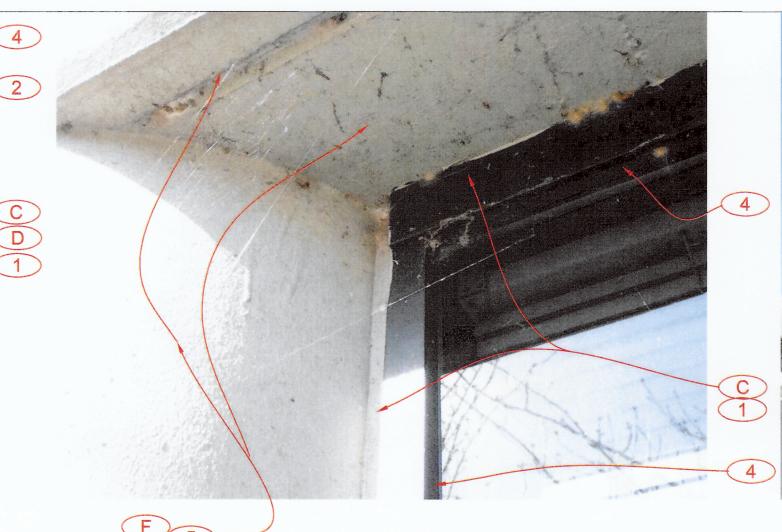

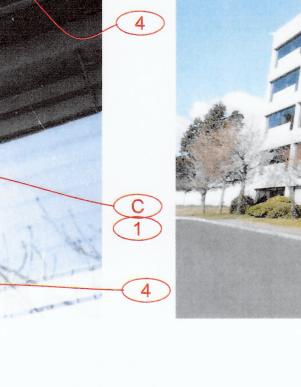

PHOTO CONCRETE WALL TO WINDOW



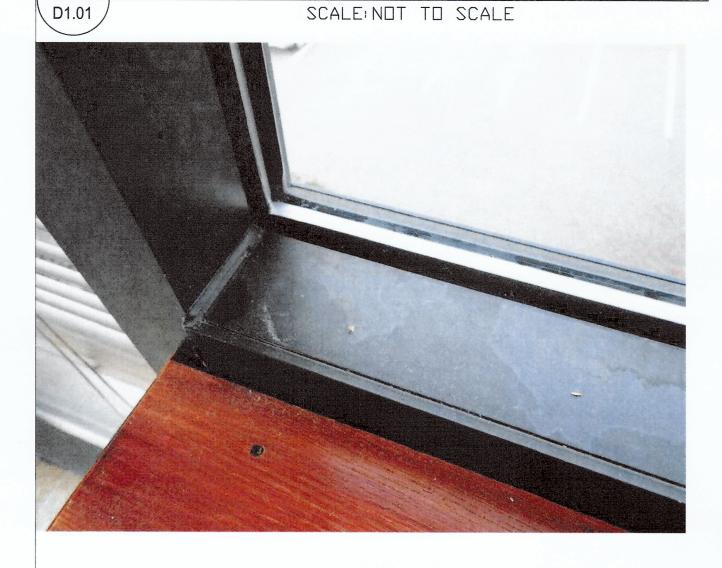


PHOTO STUCCO WALL TO WINDOW SCALE: NOT TO SCALE D1.01

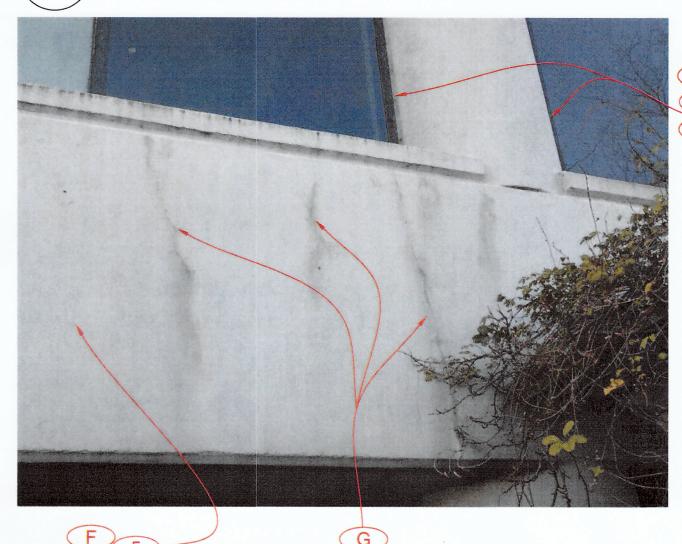

10 PHOTO WALL AND WINDOWS SCALE: NOT TO SCALE

PHOTO WALL AND WINDOW AT GRADE SCALE: NOT TO SCALE

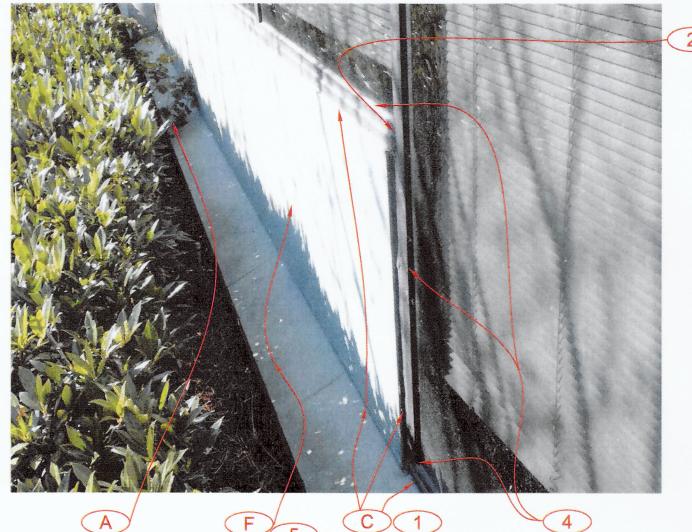

11 PHOTO WALL AND WINDOW AT GRADE SCALE: NOT TO SCALE

PHOTO WINDOW AND WALL TYPICAL D1.01 SCALE: NOT TO SCALE

#### **GENERAL NOTES**

REFER TO SUMMARY OF WORK AND PRODUCT SPECIFICATIONS

PRIOR TO SEALANT APPLICATION AND SILICONE COATING, AN ADHESION TEST PERFORMED BY THE MANUFACTURERS REPRESENTATIVE FOR COATINGS AND SEALANTS IS REQUIRED.
PROTECT GLASS FROM DAMAGE AND CLEAN AFTER COMPLETION OF WORK
MOCK UPS, ADHESION TESTS AND PERIODIC FIELD REVIEWS BY EXTERIOR CONSULTANT ARE AND

SHALL BE COORDINATED BY THE CONTRACTOR.

### TYPICAL PREPARATION KEY NOTES AS NOTED WITH: (A.B.

REMOVE EXISTING LANDSCAPING IN AREA OF WORK.
REMOVE AND SAVE FOR RESETTING ALL LIGHTS, CAMERAS, SIGNS AND OTHER ITEMS ATTACHED TO FACADE WHICH WILL BE IN THE WAY OF REPAIR WORK. RESET ITEMS AFTER COMPLETION OF WORK REMOVE ALL EXISTING SEALANTS ON BUILDING AT WINDOW FRAME TO FRAME, FRAME TO EXTERIOR SUBSTRATE, BETWEEN EXTERIOR SUBSTRATES. EXISTING SEALANTS MUST BE COMPLETELY

REMOVED PRIOR TO APPLICATION OF NEW MATERIALS. ENSURE ALL EXISTING WEEPS IN STORERFRONT SILL ARE EXPOSED AND CLEANED TO ALLOW FOR

CLEAN AND PREPARE ALL CONCRETE AND STUCCO SURFACES, AS RECOMMENDED BY COATING MANUFACTURER. PROVIDE PRESSURE WASHING AT PRESSURE RATINGS APPROVED BY COATING MANUFACTURER AND ALLOW TO DRY BEFORE COATING.

ROUTE OUT AND PREPARE ALL EXTERIOR CRACKS WITH COMPATIBLE SILICONE SEALANT PRIOR TO

H. LIFT UP OR TEMPORARILY REMOVE STANDING SEAM METAL PARAPET TO ALLOW FOR SILICONE

#### COATING UNDERNEATH. PROTECT PARAPET METAL FROM NEW COATING. REPAIR KEY NOTES AS NOTED WITH: 1,2...

WINDOW FRAME TO EXTERIOR CLADDING OR STRUCTURE. DO NOT SEAL OVER EXISTING WEEP HOLES IN STOREFRONT SILL. SEE 9A AND 9B/W3.01.

PROVIDE SEALANT BAND AIDS AT ALL STOREFRONT FRAME TO FRAME JUNCTIONS. DO NOT SEAL

OVER EXISTING WEEP HOLES IN STOREFRONT SILL. SEE 11/W3.02.
AFTER REMOVING EXTERIOR PORTION OF WINDOW GASKETS, INSTALL "WET SEAL" AT GLASS TO WINDOW FRAMES AT ALL LOCATIONS. SEE 12/W3.02.

COAT ALL PROPERLY PREPARED CONCRETE AND STUCCO SURFACES WITH 2 COATS OF SILICONE COATING. APPLIED PER MANUFACTURER RECOMMENDATIONS AFTER MANUFACTURER APPROVED


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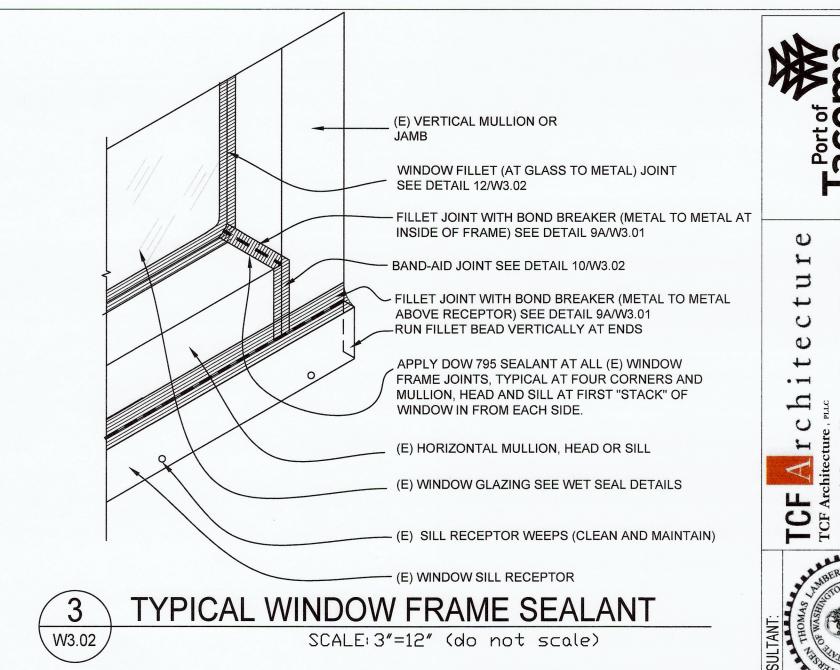
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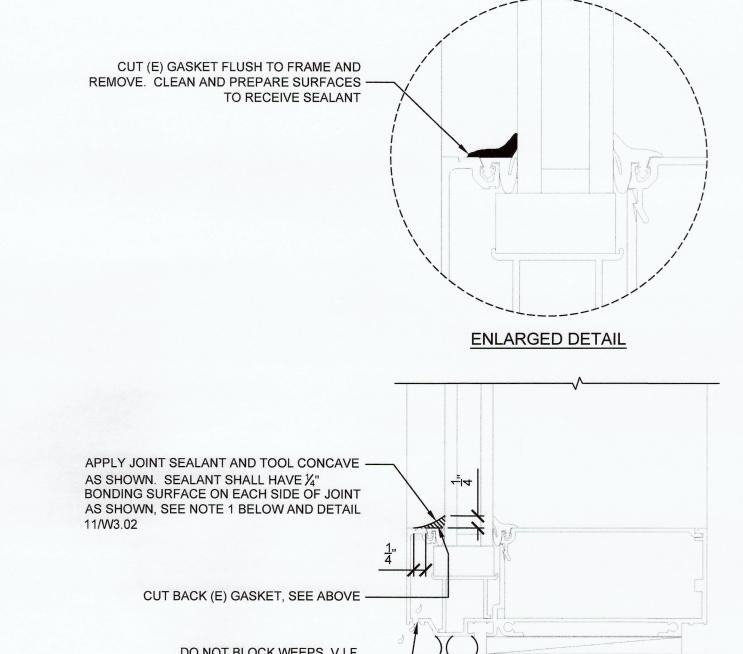
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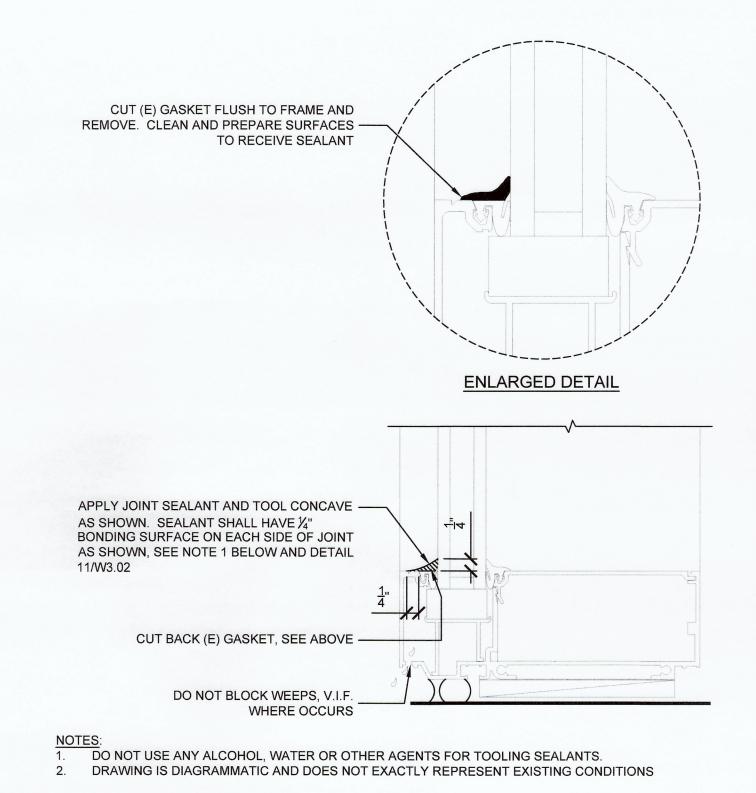
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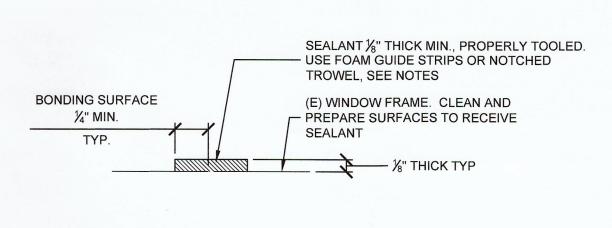










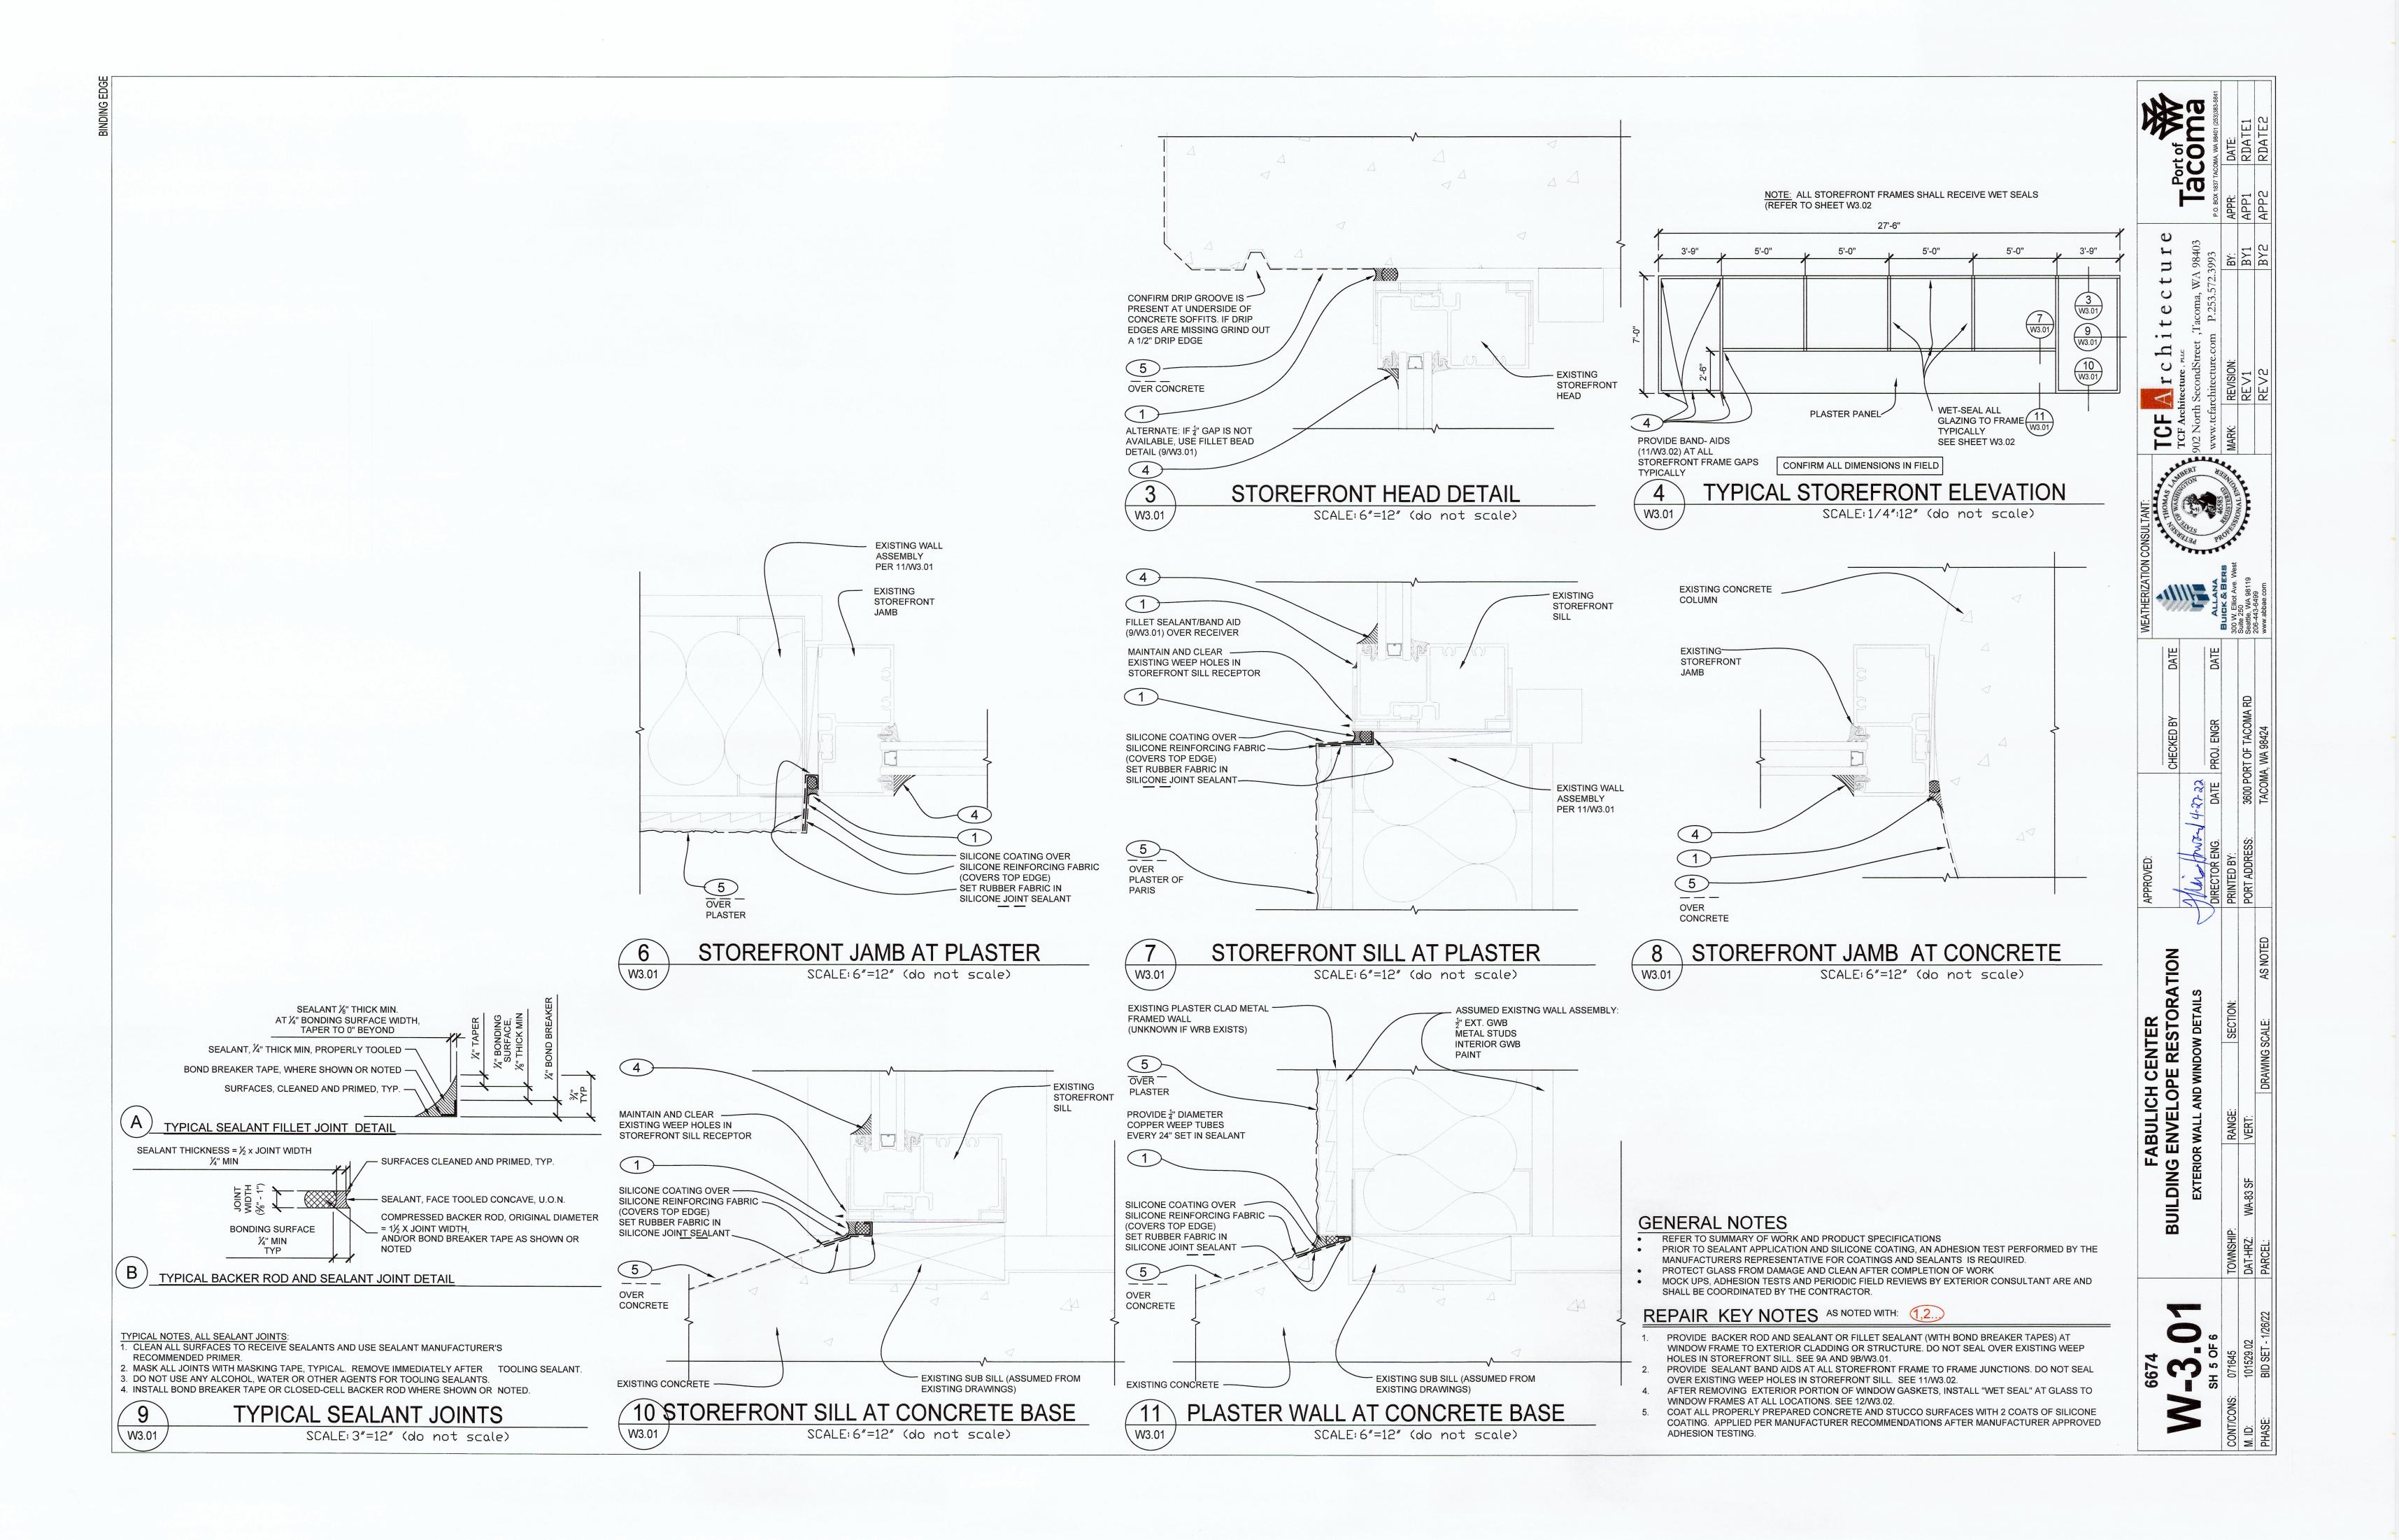

REMOVE (E) SEALANTS IN AREAS TO RECIEVE SEALANTS.
 MASK ALL JOINTS WITH MASKING TAPE, TYPICAL. REMOVE IMMEDIATELY AFTER TOOLING

3. DO NOT USE ANY ALCOHOL, WATER OR OTHER AGENTS FOR TOOLING SEALANTS.

WINDOW FRAME BAND AID JOINT W3.02 SCALE: 3"=12" (do not scale)

REMOVE (E) SEALANTS IN AREAS TO RECIEVE SEALANTS. MASK ALL JOINTS WITH MASKING TAPE, TYPICAL. REMOVE IMMEDIATELY AFTER TOOLING SEALANT. 3. DO NOT USE ANY ALCOHOL, WATER OR OTHER AGENTS FOR TOOLING SEALANTS.

(E) WINDOW FRAME —

SEE NOTES

SEALANT

SEALANT, 1/8" THICK, PROPERLY TOOLED,

(E) WINDOW FRAME. CLEAN AND

PREPARE SURFACES TO RECEIVE -

WINDOW FRAME SEALANT JOINT SCALE: 3"=12" (do not scale)

W3.02

DIAGRAM OF WET SEAL PROCEDURE

FABULICH CENTER
BUILDING ENVELOPE RESTORATION
WINDOW WET FLASH DETAILS

SCALE:6"=12" (do not scale)